

132kV GIS BUILDING

KEY PLAN

### KEY PLAN






THE INFORMATION ON THIS DOCUMENT IS THE PROPERTY OF BHARAT HEAVY ELECTRICALS LIMITED. IT MUST NOT BE USED DIRECTLY OR INDIRECTLY IN ANY WAY DETRIMENTAL TO THE INTEREST OF THE COMPANY

FIRST ANGLE PROJECTION

(ALL DIMENSIONS ARE IN mm)

TB-3-404-316-006  
DRG. NO.

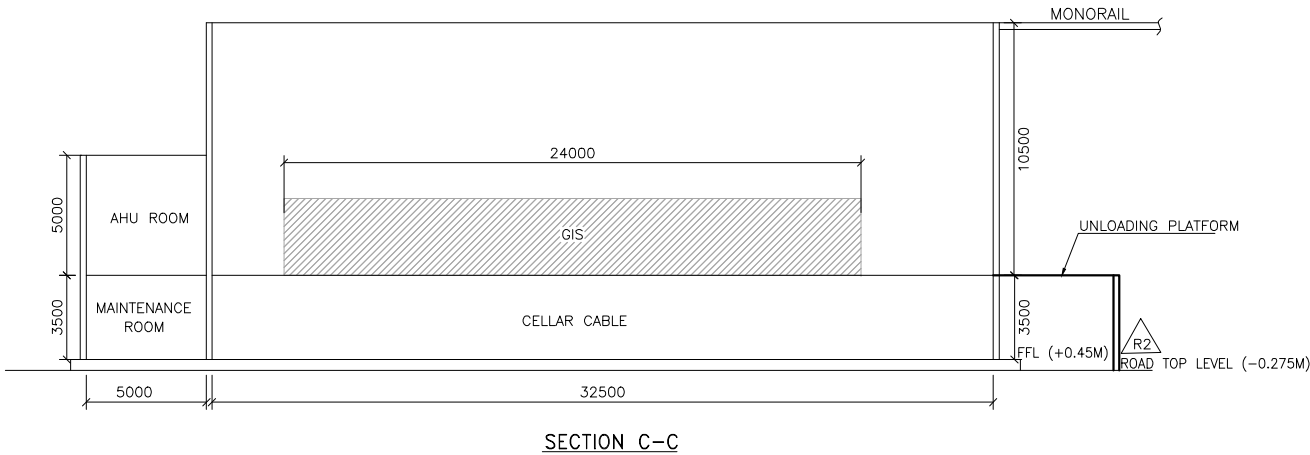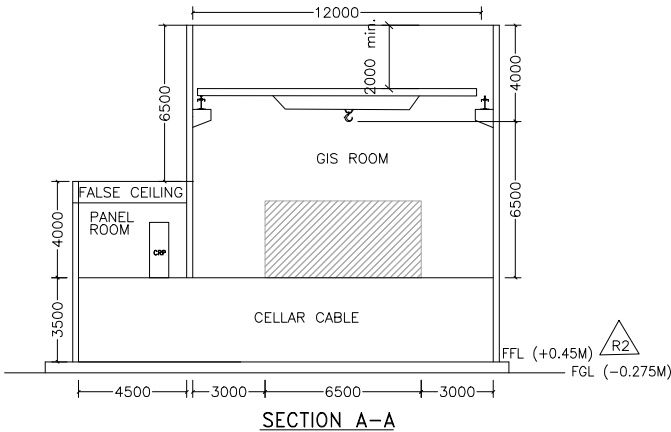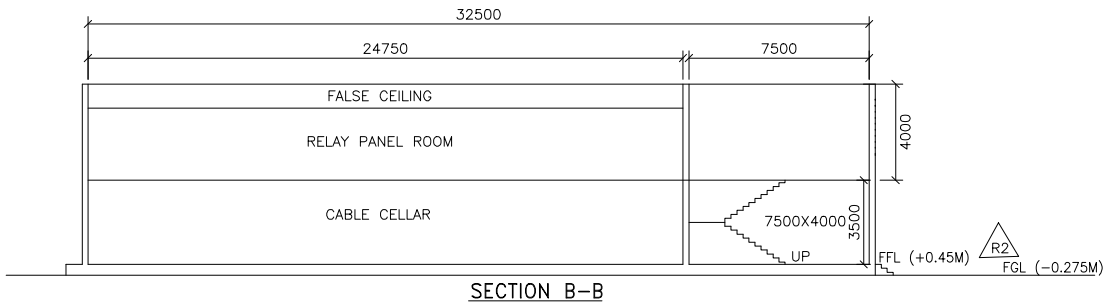

NOTE:-

1. ALL DIMENSIONS ARE IN MM AND MINIMUM CLEAR DIMENSIONS.
2. GIS ROOM SHALL BE PROVIDED WITH DUCTED VENTILATION .
3. FINAL LOCATION OF CABLE TRENCH ENTRY SHALL BE AS PER APPROVED TRENCH LAYOUT.
4. DOOR SHALL BE 2500(H)X1500(W) IN SIZE.
5. ROLLING SHUTTER FOR SHALL BE 5500(H)X4500(W) IN SIZE.
6. CAPACITY OF EOT CRANE – 6T
7. DETAILS OF STAIRS AS PER CIVIL DRG.
8. DOOR FOR AHU ROOM SHALL BE 3300(H)X2200(W) IN SIZE.


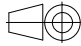
REFERENCE:-

1. LAYOUT PLAN AND SECTION DRAWING : TB-0-375-316-002

REFERENCE DRG.: - TENDER SINGLE LINE DIAGRAM 400/220/132kV GIS S/S

PROJECT:  
400/220/132kV GIS SUBSTATION AT RASARA, BALLIA (U.P.)

CUSTOMER:  
UTTAR PRADESH TRANSMISSION CORPORATION LIMITED

	BHARAT HEAVY ELECTRICALS LTD. TRANSMISSION BUSINESS GROUP NOIDA				NAME	SIGN.	DATE	NO.OF VAR.
	DRN.	PK			21.09.18			
	CHD.	MM/DKM						N.A.
	APPD.	AG						
DEPT. TBG CODE	UNTOL. DIMS. GR. 9/M/f		SCALE N.T.S	WEIGHT (KG) N.A.	REF. TO ASSY. DRG. N.A.	ITEM NO. N.A.	NO.OF ITEMS N.A.	REV. 02
TITLE CONCEPTUAL DRAWING FOR 132kV GIS BUILDING				CARD CODE NA	DRG.NO. TB-3-404-316-006	SHT. No 02	NO. OF SHT. 02	

REV.	DATE	ALTERED	REV.	DATE	ALTERED	REV.	DATE	ALTERED	REV.	DATE	ALTERED
		CHD/APPD			CHD/APPD	02	08.01.19	CHD/APPD	PK	19.11.18	CHD/APPD
ZONE			ZONE			ZONE			ZONE		

8

7

6

5

4

3

2

1

SIZE-A3